



DUNN EDWARDS
PALE BEACH
DE6199


BENJAMIN MOORE
MOCHA BROWN
2107-20

BENJAMIN MOORE
EXOTIC RED
2086-10

BENJAMIN MOORE
RAINFOREST FOLIAGE
2040-10

EL DORADO STONE
SANTA BARBARA
ASHLAR

POPEYE'S LOUISIANA KITCHEN
CONCEPTUAL DRAINAGE & UTILITY PLAN
1431 S. CRISMON ROAD, MESA, ARIZONA

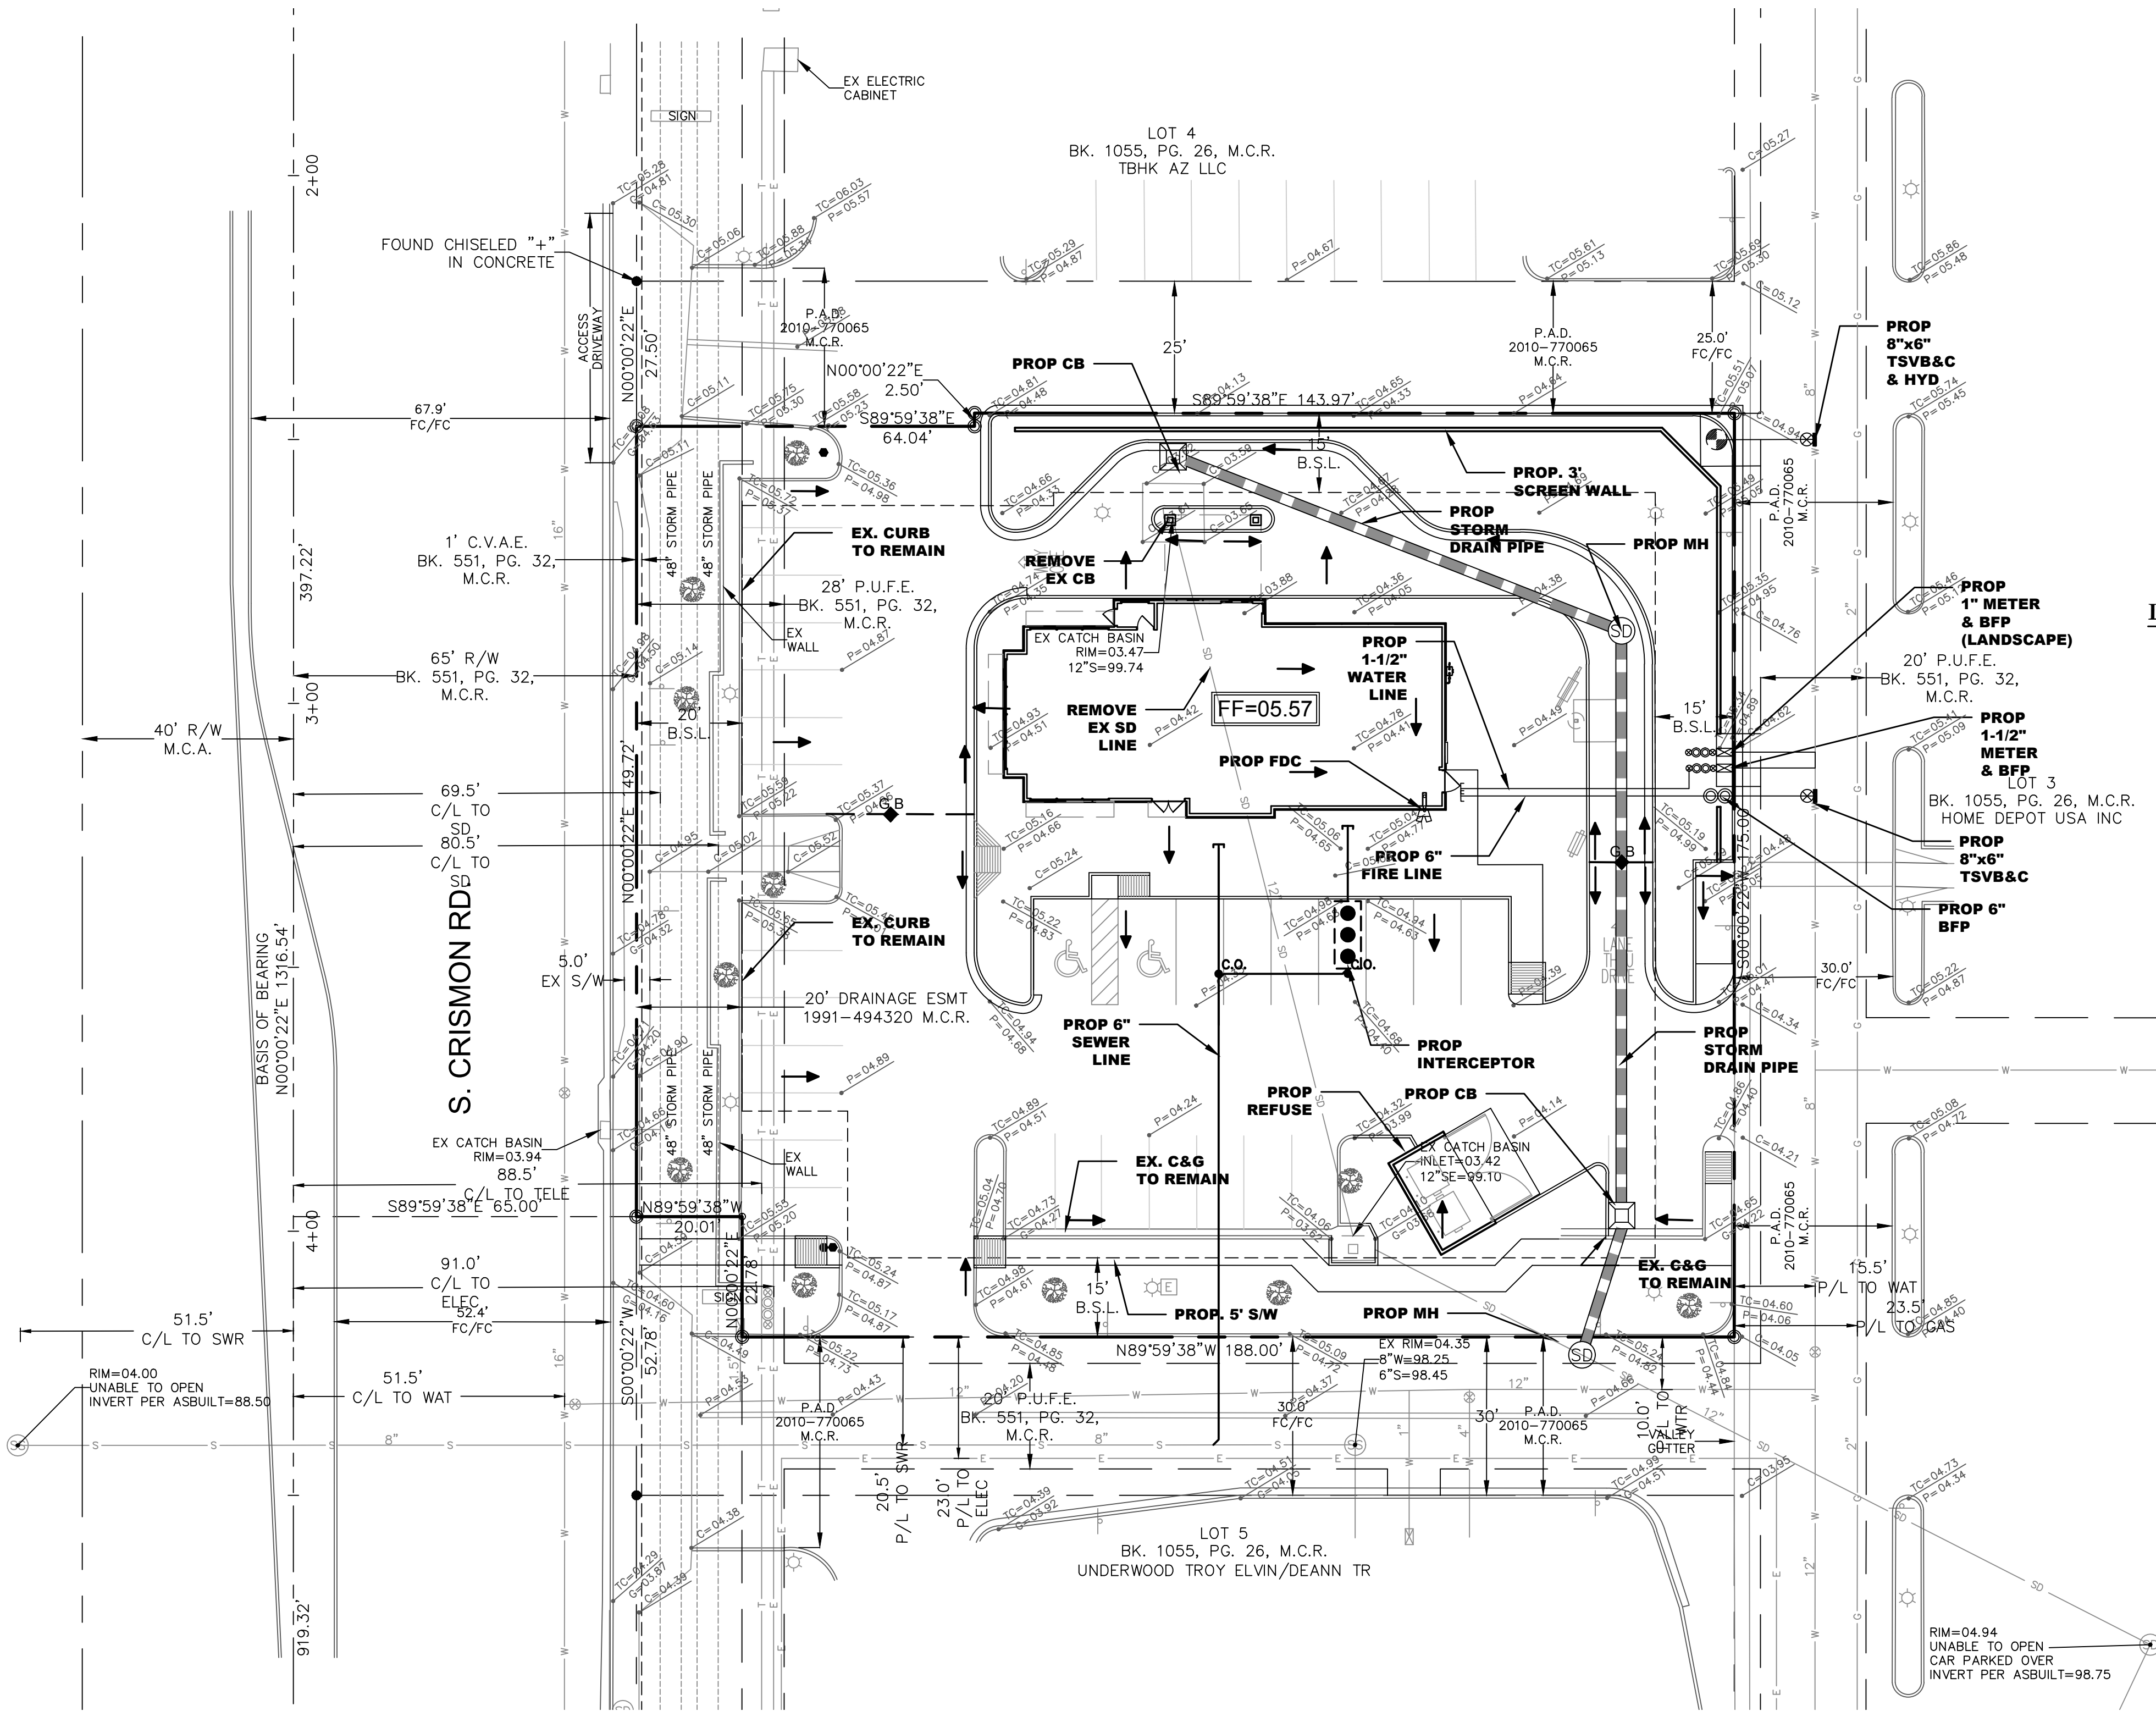

LEGEND OF EXISTING FEATURES

- FOUND BRASS CAP FLUSH
- FOUND BRASS CAP IN HANDHOLE
- FOUND MONUMENT AS NOTED
- SET MAG NAIL & WASHER RLS #45763
- CALCULATED POSITION, NOTHING SET
- FIRE HYDRANT
- ⊠ WATER METER
- ⊠ WATER VALVE
- ⊠ BACKFLOW PREVENTER
- ⊠ SANITARY SEWER MANHOLE
- ⊠ STORM DRAIN MANHOLE
- ☆ LIGHT POLE
- ⊠ ELECTRIC JUNCTION BOX
- ⊠ TELEPHONE RISER
- IRRIGATION CONTROL VALVE
- SIGN
- TREE
- GROUND ELEVATION
- PAVEMENT ELEVATION
- TOP OF CURB & GUTTER ELEVATION
- TOP OF CURB & PAVEMENT ELEVATION
- CONCRETE ELEVATION

- A.P.N. ASSESSOR PARCEL NUMBER
- B.S.L. BUILDING SETBACK LINE
- C.V.A.E. CONTROLLED VEHICULAR ACCESS EASEMENT
- P.U.F.E. PUBLIC UTILITY AND FACILITIES EASEMENT
- ESMT EASEMENT
- I.D. IDENTIFICATION
- BK. BOOK
- PG. PAGE
- M.C.R. MARICOPA COUNTY RECORDER
- M.C.A. MARICOPA COUNTY ASSESSOR
- R/W RIGHT-OF-WAY
- FC FACE OF CURB
- PL PROPERTY LINE
- SD — STORM DRAIN LINE
- S — SANITARY SEWER LINE
- W — WATER LINE
- T — TELEPHONE LINE
- E — ELECTRIC LINE
- G — GAS LINE
- CTV — CABLE TV LINE
- CONCRETE

- P.A.D. PERMANENT ACCESS DRIVE
- SCHEDULE "B" ITEM PER TITLE COMMITMENT

RETENTION STATEMENT

THIS SITE WILL RESPECT THE CURRENT DESIGN CONDITIONS. THE ONLY CHANGE WILL BE RELOCATING THE NORTH EXISTING CATCH BASIN AND RELOCATING THE STORM DRAIN PIPE AROUND THE NEW BUILDING LOCATION. NO OFF-SITE FLOWS IMPACT THIS SITE.

DEVELOPER/OWNER

Z&H FOODS, INC.
3100 MAIN STREET
SUITE 301
DALLAS, TX 75226
CONTACT: JEFFERY BENNETT

ARCHITECT

ID STURDIO 4, LLC
15650 N. BLACK CANYON HWY. #B-235
PHOENIX, AZ 85053
PH: (602) 938-1453
CONTACT: ALEX RAMON

ENGINEER:

SBL ENGINEERING, LLC.
1957 E. SUNBURST LANE,
TEMPE, AZ 85284
PH: (602) 326-5848
FX: (480) 619-6334
CONTACT: JENNIFER SMITH

SURVEYOR:

LSRS LAND SURVEY
2231 W. CALLE DEL SOL
PHOENIX, AZ 85085
PH: (480) 650-4006
FX: (480) 718-7668
CONTACT: JAY VANLANDSCHOOT

BENCHMARK

CRISMON ROAD AND US 60 BRASS TAG T.C. MEDIAN APPROXIMATELY 440 FT SOUTH OF T1N R7E 34 E1/4 CORNER. ELEVATION=1498.38 NAVD88 (CITY OF MESA DATA)

BASIS OF BEARING

BEARINGS ARE BASED ON THE WEST LINE OF THE NORTHWEST QUARTER OF SECTION 35, WHICH BEARS N00°00'22"E AS SHOWN ON LOT 3 OF CRISMON BUSINESS PARK LOT SPLIT, RECORDED IN BOOK 1055 OF MAPS, PAGE 26, M.C.R.

PARCEL & SITE ADDRESS

APN: 220-81-402A
SITE ADDRESS 1431 S. CRISMON ROAD, MESA, ARIZONA 85209
ZONING: THIS SITE IS CURRENTLY ZONED AS LC

AREA:

35,786 SQFT
0.82 ACRES

FLOOD ZONE

ACCORDING TO THE FLOOD INSURANCE RATE MAP #04013C2315L, DATED OCTOBER 16, 2013 (PANEL NOT PRINTED), THIS PROPERTY IS LOCATED IN FLOOD ZONE "X"; AREAS OF 0.2% ANNUAL CHANCE FLOOD; AREAS OF 1% ANNUAL CHANCE FLOOD WITH AVERAGE DEPTHS OF LESS THAN 1 FOOT OR WITH DRAINAGE AREAS LESS THAN 1 SQUARE MILE; AND AREAS PROTECTED BY LEVEES FROM 1% ANNUAL CHANCE FLOOD.

LEGAL DESCRIPTION

PARCEL NO. 1:
LOT 3A, OF LOT 3 OF CRISMON BUSINESS PARK LOT SPLIT, ACCORDING TO THE PLAT OF RECORD IN THE OFFICE OF THE COUNTY RECORDER OF MARICOPA COUNTY, ARIZONA, RECORDED AS BOOK 1055 OF MAPS, PAGE 26 AND AFFIDAVIT OF CORRECTION, RECORDED AUGUST 24, 2010, AS 2010-0724861 OF OFFICIAL RECORDS.


PARCEL NO. 2:
NON-EXCLUSIVE EASEMENTS FOR UTILITIES, INGRESS AND EGRESS BY VEHICULAR AND PEDESTRIAN TRAFFIC, PARKING, LANDSCAPE AND DRAINAGE, AS SET FORTH IN DECLARATION OF COVENANTS, CONDITIONS AND RESTRICTIONS, RECORDED JANUARY 12, 2001, AS 2001-0026505 OF OFFICIAL RECORDS, AND SUPPLEMENTAL DECLARATION RECORDED MAY 27, 2010 AS 2010-0450803 OF OFFICIAL RECORDS AND RE-RECORDED MAY 28, 2010 AS 2010-0455529 OF OFFICIAL RECORDS AND RE-RECORDED AUGUST 27, 2010 AS 2010-0741123 OF OFFICIAL RECORDS AND RE-RECORDED SEPTEMBER 07, 2010 AS 2010-0770065 OF OFFICIAL RECORDS.

LEGEND OF PROPOSED FEATURES

- G.B. GRADE BREAK
- DRAINAGE FLOW
- SD SD MH
- ⊠ CATCH BASIN
- FF=XX.XX FINISH FLOOR
- STORM DRAIN PIPE
- FDC
- ⊠ WATER VALVE
- FIRE HYDRANT
- ⊠ WATER METER
- ⊠ BACKFLOW PREVENTION DEVICE
- LOT OUTFALL
- C.O. SEWER CLEANOUT



SCALE: 1"= 20'

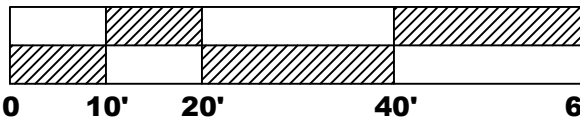

PRELIMINARY
NOT FOR CONSTRUCTION
OR RECORDING

CALL TWO WORKING DAYS
BEFORE YOU DIG
602-263-1100
1-800-STAKE-IT
(OUTSIDE MARICOPA COUNTY)

SBL Engineering, LLC.
44734
JENNIFER J. SMITH
Professional Engineer
No. 12474
Arizona
Expires 06/30/2018

VICINITY MAP
N.T.S.

POPEYE'S LOUISIANA KITCHEN
1431 S. CRISMON ROAD, MESA, AZ
CONCEPTUAL DRAINAGE & UTILITY PLAN

DATE	
REVISIONS	

DATE:	12/24/15
PROJ. NO:	15-1036
DESIGN:	CB
DRAWN:	CB
CHECK:	JS
SCALE:	1"=20'
CAD FILE:	15136DX

CONCEPT G&D
UTILITY PLAN
CP1
1 of 1

C.O.M. LOG NO. PLN2015-00014

L-1



CORPORATE

Z & H FOODS, INC
3100 MAIN STREET #301
DALLAS, TEXAS 75226

ZNHFOODSINC.COM




POPEYES
CRISMON & HAMPTON

1431 S CRISMON ROAD

1431 S CRISMON ROAD
MECA, ARIZONA 85205

1431 S CRISMON ROAD
MECA, ARIZONA 85205

1431 S CRISMON ROAD
MECA, ARIZONA 85205

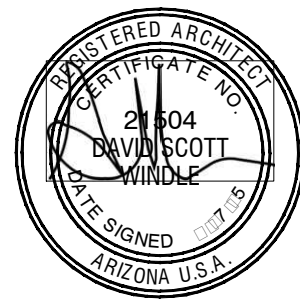

EXP DATE: 12/31/10

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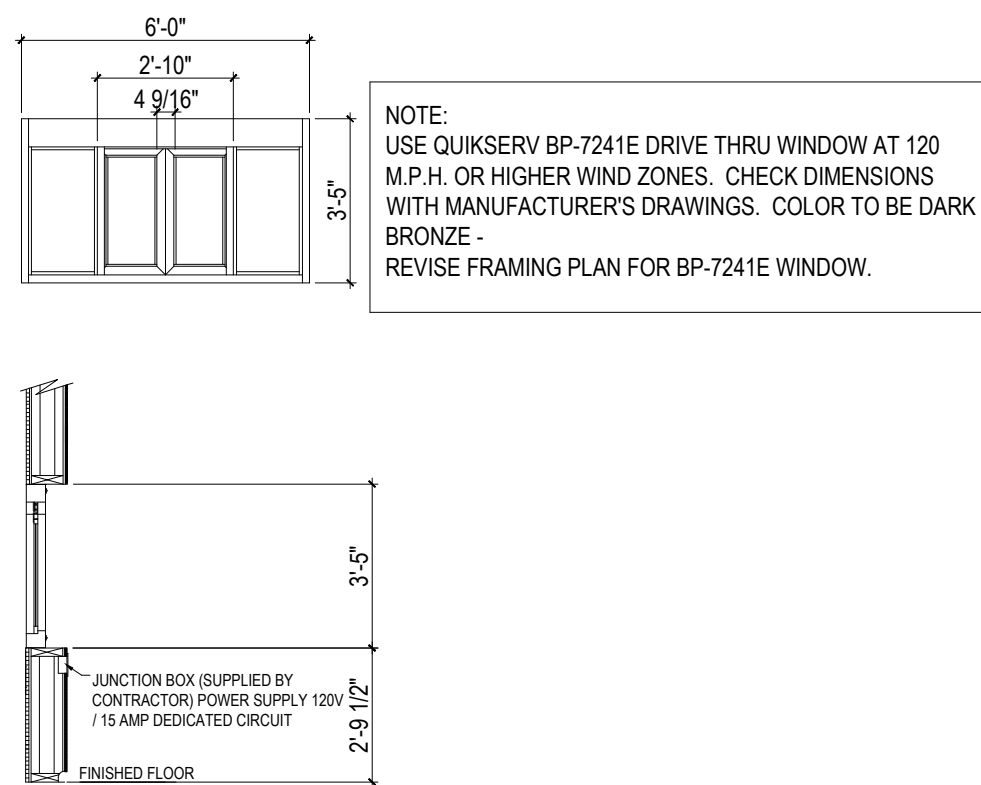
SITE PLAN

SHEET NUMBER:


SD100

PROJECT NUMBER


POP15003



DRIVE-THRU WINDOW DETAIL
NTS 20

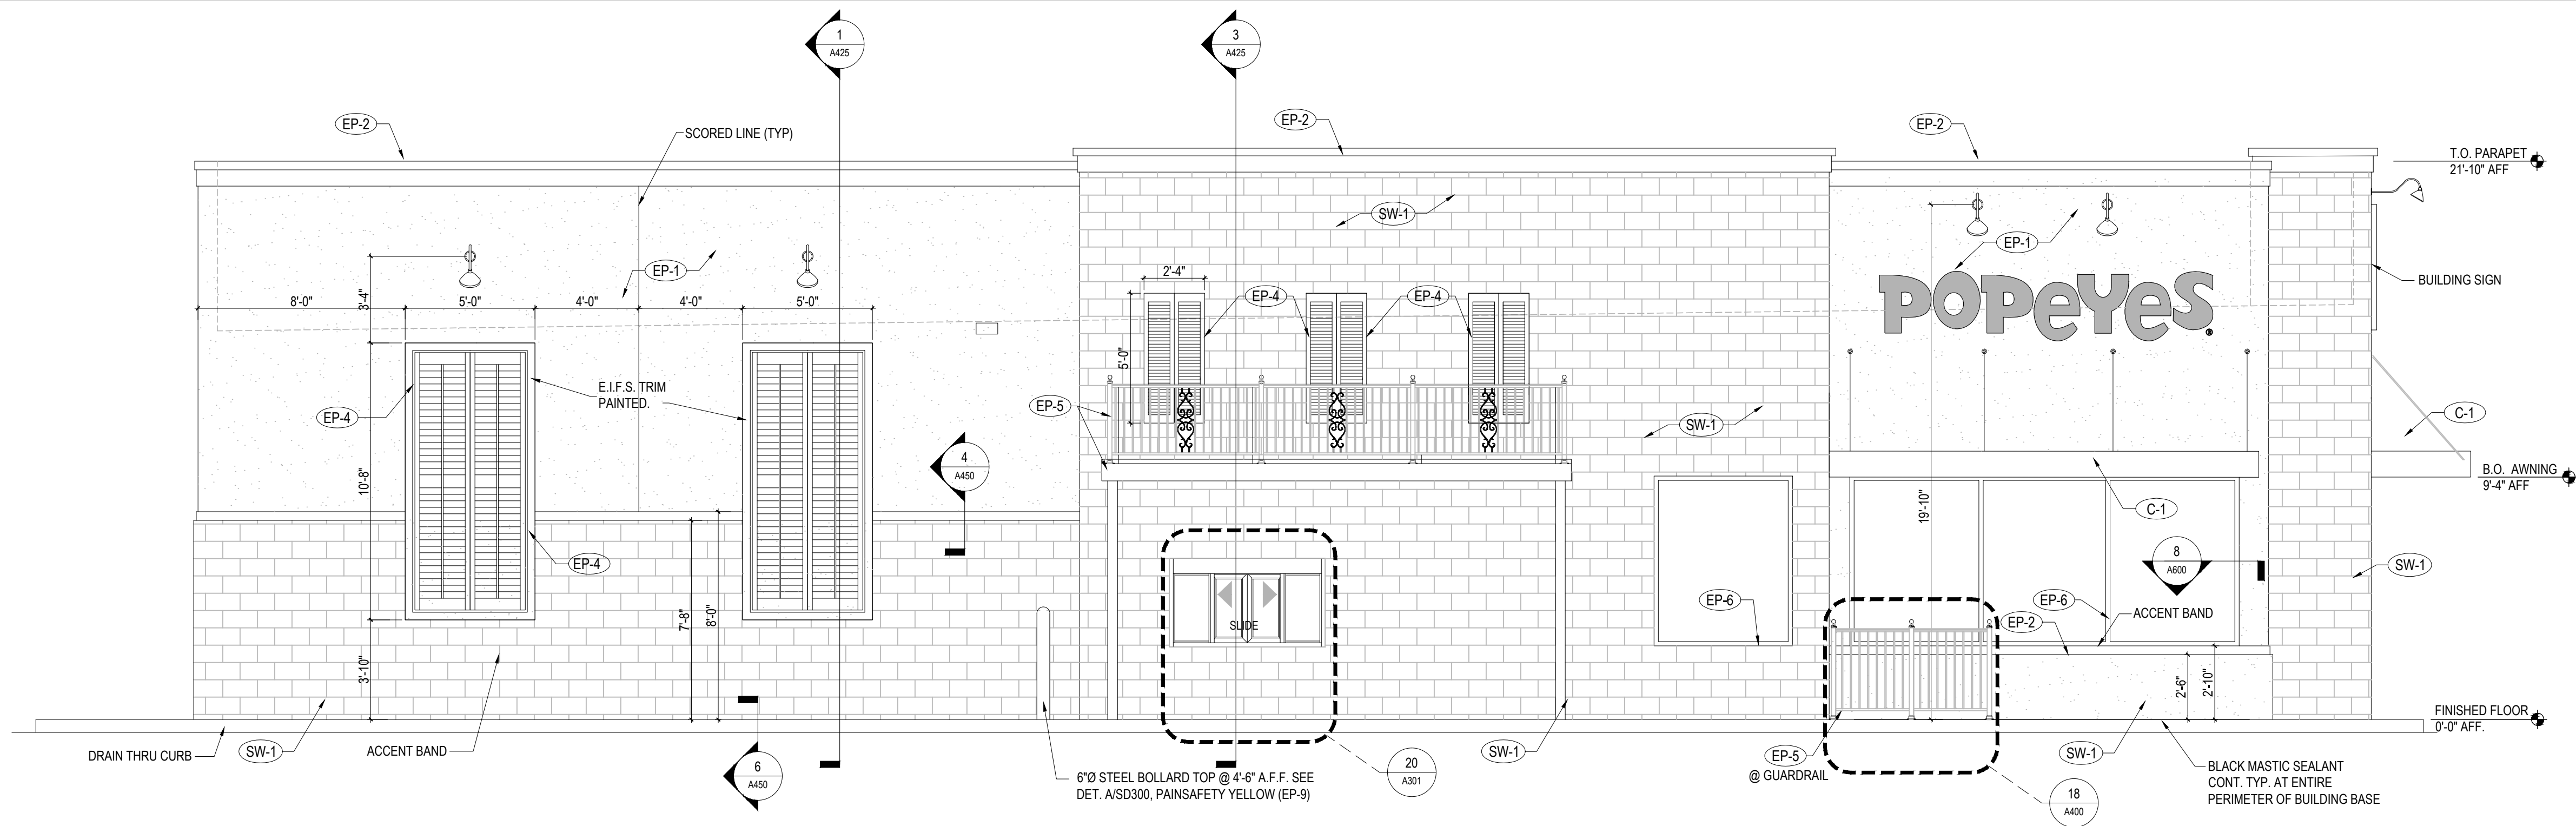

NORTH ELEVATION 3
1/4"=1'-0"

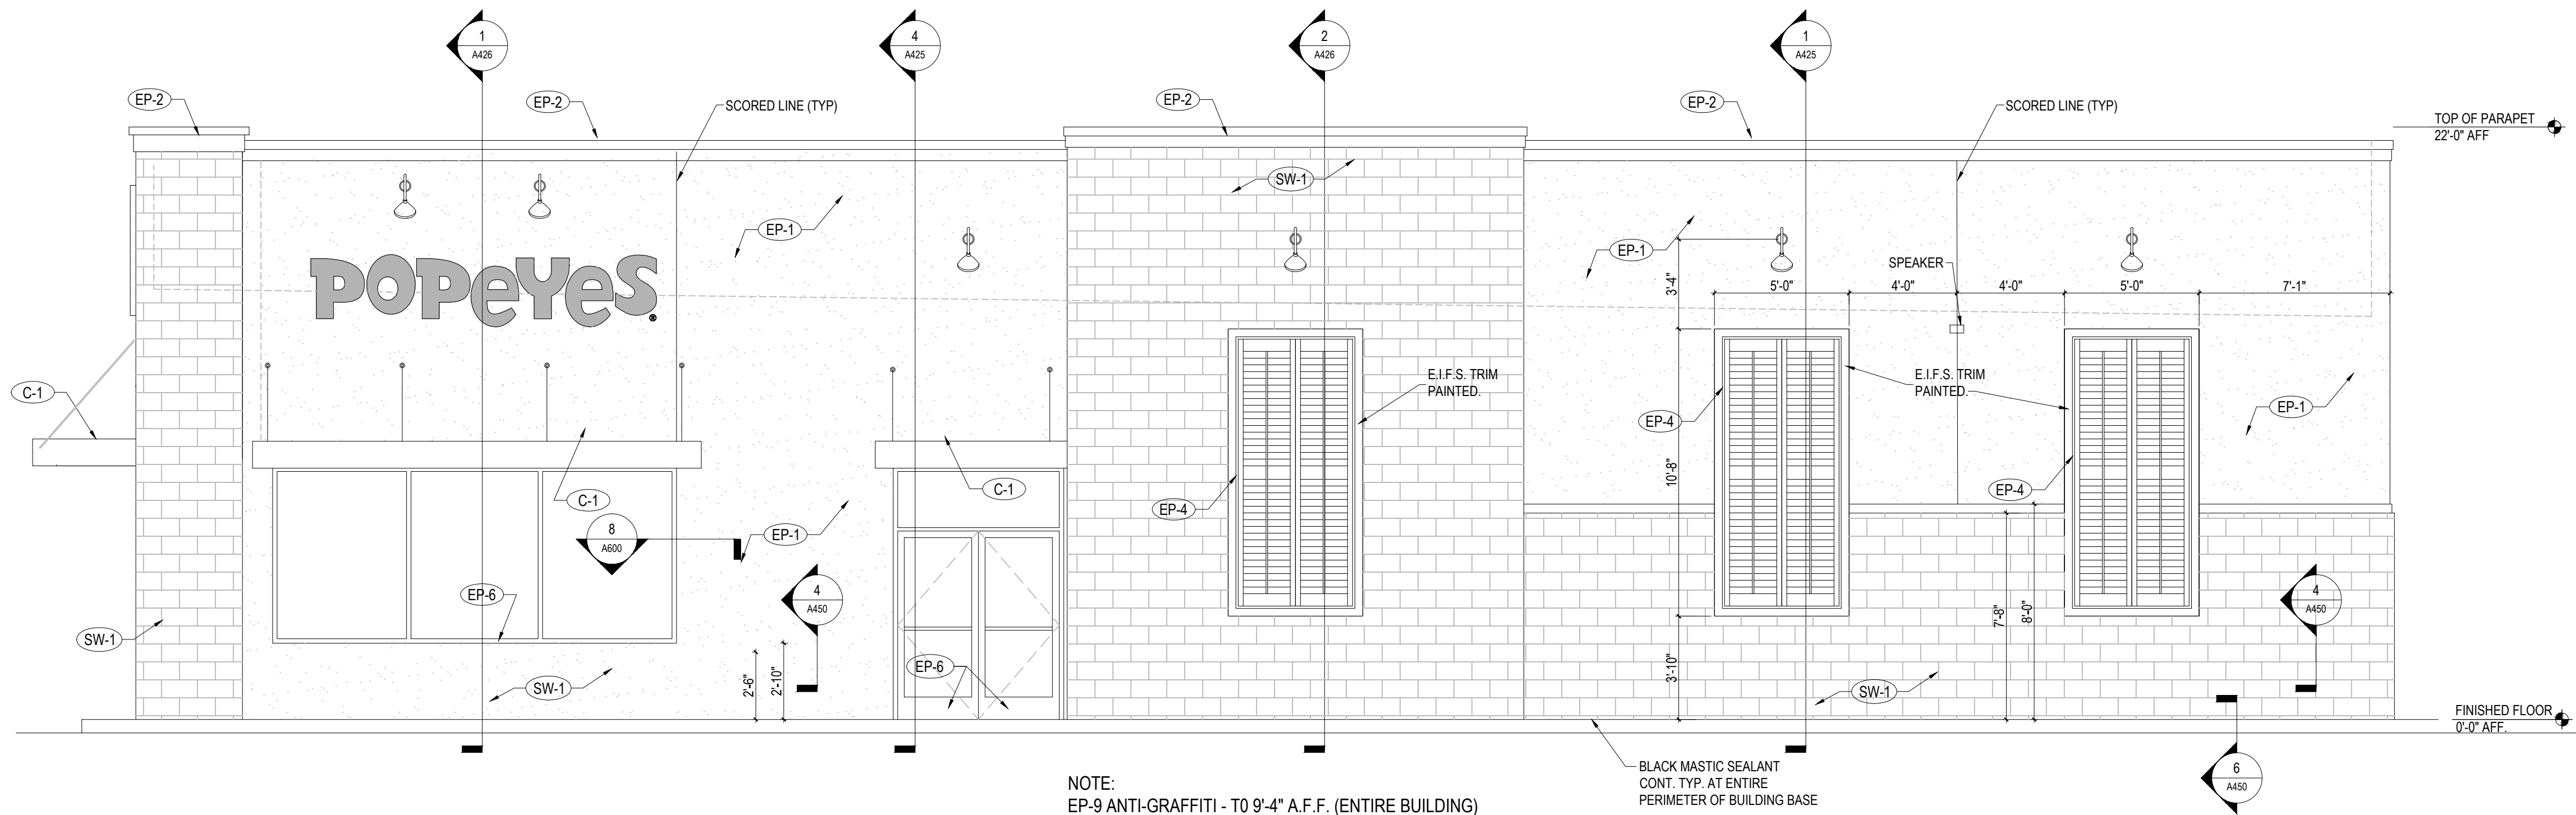

SOUTH ELEVATION
1/4"=1'-0" 2

SECTION 8A: ALUMINUM ENTRANCE, STOREFRONT

GENERAL PROVISIONS
SCOPE: FURNISH AND INSTALL THE ALUMINUM ENTRANCE AND STOREFRONT SYSTEMS PER
NATIONAL ACCOUNTS AND APPLICABLE DRAWINGS.

MATERIALS

1. ALUMINUM STOREFRONT AND ENTRANCE FRAMES: REFER TO CONSTRUCTION DRAWINGS AND SPECIFICATIONS.
2. ALUMINUM ENTRANCE DOORS: REFER TO CONSTRUCTION DRAWINGS AND SPECIFICATIONS.
3. PANIC HARDWARE: WHEN PANIC HARDWARE IS REQUIRED ON EXTERIOR DOORS, THE PANIC DEVICE IS ON EXTERIOR ENTRY DOORS WHEN SPECIFIED IN HARDWARE SCHEDULE.
4. DRIVE-THRU SERVICE WINDOW: THE DRIVE-THRU SERVICE WINDOW WILL BE SUPPLIED & INSTALLED BY G.C. VERIFY EXACT TYPE OF WINDOW WITH PLANS. BRONZE FINISH.

WINDOW TO BE:

5. MISCELLANEOUS FLASHING/TRIM: ALUMINUM HEAD, SILL, COLUMN AND WALL TRIM. SEE EXTERIOR ELEVATIONS FOR FINISH.

PERFORMANCE

1. INSTALLATION: INSTALL IN ACCORDANCE WITH MANUFACTURER'S INSTRUCTION. PLACE IN CORRECT LOCATION AS SHOWN IN THE DETAILS. LEVEL, SQUARE, AND PLUMB AT PROPER ELEVATIONS AND IN ALIGNMENT WITH OTHER WORK. MAINTAIN SPACE IN HEAD POCKET FOR 1/4" HEAD DEFLECTION. INSURE FRAMING PROFILES MEET INSTALLATION REQUIREMENTS OF GLAZING UNITS TO MAINTAIN WARRANTY. SEE SECTION 8-D: GLAZING.

SECTION 8D: GLAZING

GENERAL PROVISIONS

1. SCOPE: FURNISH AND INSTALL GLASS IN STOREFRONT AND DRIVE-THRU SERVICE WINDOW.

2. QUALITY CONTROL: ALL GLASS BROKEN DURING INSTALLATION OR DURING CONSTRUCTION

GLASS SHC

- THE OWNER'S REPRESENTATIVE INSPECTS IT.
- MATERIALS

PERFORMANCE

1. INSTALLATION: INSTALL GLAZING WITH MANUFACTURER'S INSTRUCTIONS TO PROVIDE COMPLIANCE WITH LOCAL CODE REQUIREMENTS INCLUDING WIND RESISTANCE, 25 PSF MIN., SNOW LOAD, 20 PSF MIN. GLAZING PANELS SHALL BE INSTALLED.

ULTRA VIOLET DEGRADATION

2. ALLOW FOR 1/4" MINIMUM HEAD DEFLECTION DUE TO LIVE LOAD.

3. GUARANTEE

- WATERTIGHT BY SPRAYING ALL JOINTS WITH A GARDEN HOSE WITH NOZZLE SET FOR MAXIMUM PRESSURE. PROVIDE ADDITIONAL CAULKING OR SEALANT, OR RESET GLASS AS NECESSARY TO EFFECT A WATERTIGHT JOB.

POPEYES LOUISIANA KITCHEN				Exterior Finish Schedule			EXTERIOR FINISH NOTES			
New Construction and Reimaging				Update: 5/3/2012						
							E.I.F.S. WALL TEXTURE FINISH		STO COLORS	
Mark	Location	Supplier / Manuf.	Material	Specification	Color	Finish / Notes	Manuf.	Texture		
E:001	MAIN □ ALL SURFACE ABOVE ACCENT TRIM	DUNN ED: ARDS	□ AINT □ EIFS FORMULA	DE6 □ □	□ ALE BEACH	□ □ 5 LO □ LUSTRE	STO	STO ESSENCE S □ IRL	NA □ 0 00 □ 6 □ DELIGHTFUL GOLDEN	
E:001	□ ALL SURFACE ACCENT □ SHUTTER BORDERS	BEN: AMIN MOORE	□ AINT □ EIFS FORMULA	□ □ 0 6 □ 0	E □ OTIC RED	□ □ 5 LO □ LUSTRE	DR: VIT	□ UART □ OUT □	NA □ 0 006 □ □ E □ OTIC RED	
E:001	□ AINTSCOT BELO □ ACCENT TRIM		EIFS □ METAL □ AINT	□ □ 07 □ 0	MOCHA BRO: N	□ □ 5 LO □ LUSTRE			NA □ 0 00 7 □ MOCHA BRO: N	
E:001	SHUTTERS	SHUTTERCONTRACTOR.COM	DECORATIVE METAL	TBD	UNFINISHED	0 0 □ AINTABLE	FINISH NOTES		DRYVIT COLORS	
			DECORATIVE METAL	TBD	UNFINISHED	0 0 □ AINTABLE	THE FOLLOWING COMPONENTS CAN BE PURCHASED FROM THE APPROVED SIGN VENDORS:		□ □ E □ 05 □ 0 □ DELIGHTFUL GOLDEN	
E:005		BEN: AMIN MOORE	□ AINT	□ □ 0 0 □ 0	RAINFORST FOLIAGE	□ 70 SEMI GLOSS			□ □ E □ 0 □ 7 □ E □ OTIC RED	
E:005	CANO □ □ AND RAILINGS	RAILING VENDOR □ TIGER DR: LAC	METAL □ □ □ DER COAT	RAL 600 □	HUNTER GREEN	SMOOTH		□ STANDING SEAM ROOF	□ □ E □ 0 □ 7 □ E □ OTIC RED	
E:005	ALT □	RAILING VENDOR □ BEN: AMIN MOORE	METAL □ AINT	□ □ 0 0 □ 0	RAINFORST FOLIAGE	□ □ □ DTM S □ □ G □ □		□ BALCON □ RAILING	□ □ E □ 0 □ 7 □ E □ OTIC RED	
E:006	STORE FRONT GLA □ ING	□ □ □ A □	ANODI □ ED ALUMINUM	□ □ BSN	DAR □ BRON □ ETONE	□ □ □ □ DA □ S		□ CLEARANCE BAR	□ □ E □ 0 □ 7 □ E □ OTIC RED	
E:006	STORE FRONT GLA □ ING							□ MENU CANO □ □	□ □ E □ 0 □ 7 □ E □ OTIC RED	
E:007	DUM □ STER □ ALLS □ GATES							□ GUARD RAIL	□ □ E □ 0 □ 7 □ E □ OTIC RED	
E:001	BOLLARDS □ LOT STRI □ ING	BEN: AMIN MOORE		□ □ 07 □ 0	MOCHA BRO: N	□ □ 5 LO □ LUSTRE		□ A □ NINGS	□ □ E □ 0 □ 7 □ E □ OTIC RED	
S □ □		ELDORADO STONE	METAL □ AS □ HALT □ AINT	SAFET □ □ CONE ACR □ LIC MAR □ ING	RM SAFET □ □ ELLO □	□ □ 5 □ 0		□ SHUTTERS	□ □ E □ 0 □ 7 □ E □ OTIC RED	
SG □ □	STONE □ AINS COAT	□ UI □ RETE	SIMULATED STONE VENEER	RUSTIC LEDGE	SA □ TOOTH	OVERLA □ ING			□ □ E □ 0 □ 7 □ E □ OTIC RED	
G □ □	A □ NING GRATE □ O □ T □	A □ NING SU □ LLIER	STONE VENEER MORTAR	□ OL □ MER MODIFIED	MOCHA BRO: N	□ □ 7 □ 5			□ □ E □ 0 □ 7 □ E □ OTIC RED	
C □ □	ANDING GRATE □ O □ T □	□ NING SU □ LLIER	METAL □ □ □ DER COAT	RAL 600 □	HUNTER GREEN	SMOOTH		□ LADDER	□ □ E □ 0 □ 7 □ E □ OTIC RED	
	ANDING SEAM CANO □ □	CO □ ER SALES □ INC.	UNA □ CLAD	UC □ ALUMINUM	REGAL RED	□ □ □ OC □ GUAGE □ ER □ LOCAL CODE □ E □ URE □ MENTS		□ DUM □ STER GATES	□ □ E □ 0 □ 7 □ E □ OTIC RED	
E:001	ANTI GRAFFITI □ TO □ □ □ * □ ENTIRE BUILDING □	BEN: AMIN MOORE	□ AINT	ALI □ HATIC ACR □ LIC URETHANE	CLEAR GLOSS	M7 □ 00 □ M75 □ COATS □			□ □ E □ 0 □ 7 □ E □ OTIC RED	

SPECIFICATIONS 4

EXTERIOR FINISH SCHEDULE 1

CORPORATE

Z & H FOODS, INC
3100 MAIN STREET #301
DALLAS, TEXAS 75226

SINC.COM



**POPEYES
CRISMON & HAMPTON**

1431 S CRISMON ROAD
MESA, ARIZONA 85209

**CLIENT: Z & H FOODS, INC.
3100 MAIN STREET #301
DALLAS, TEXAS 75226**

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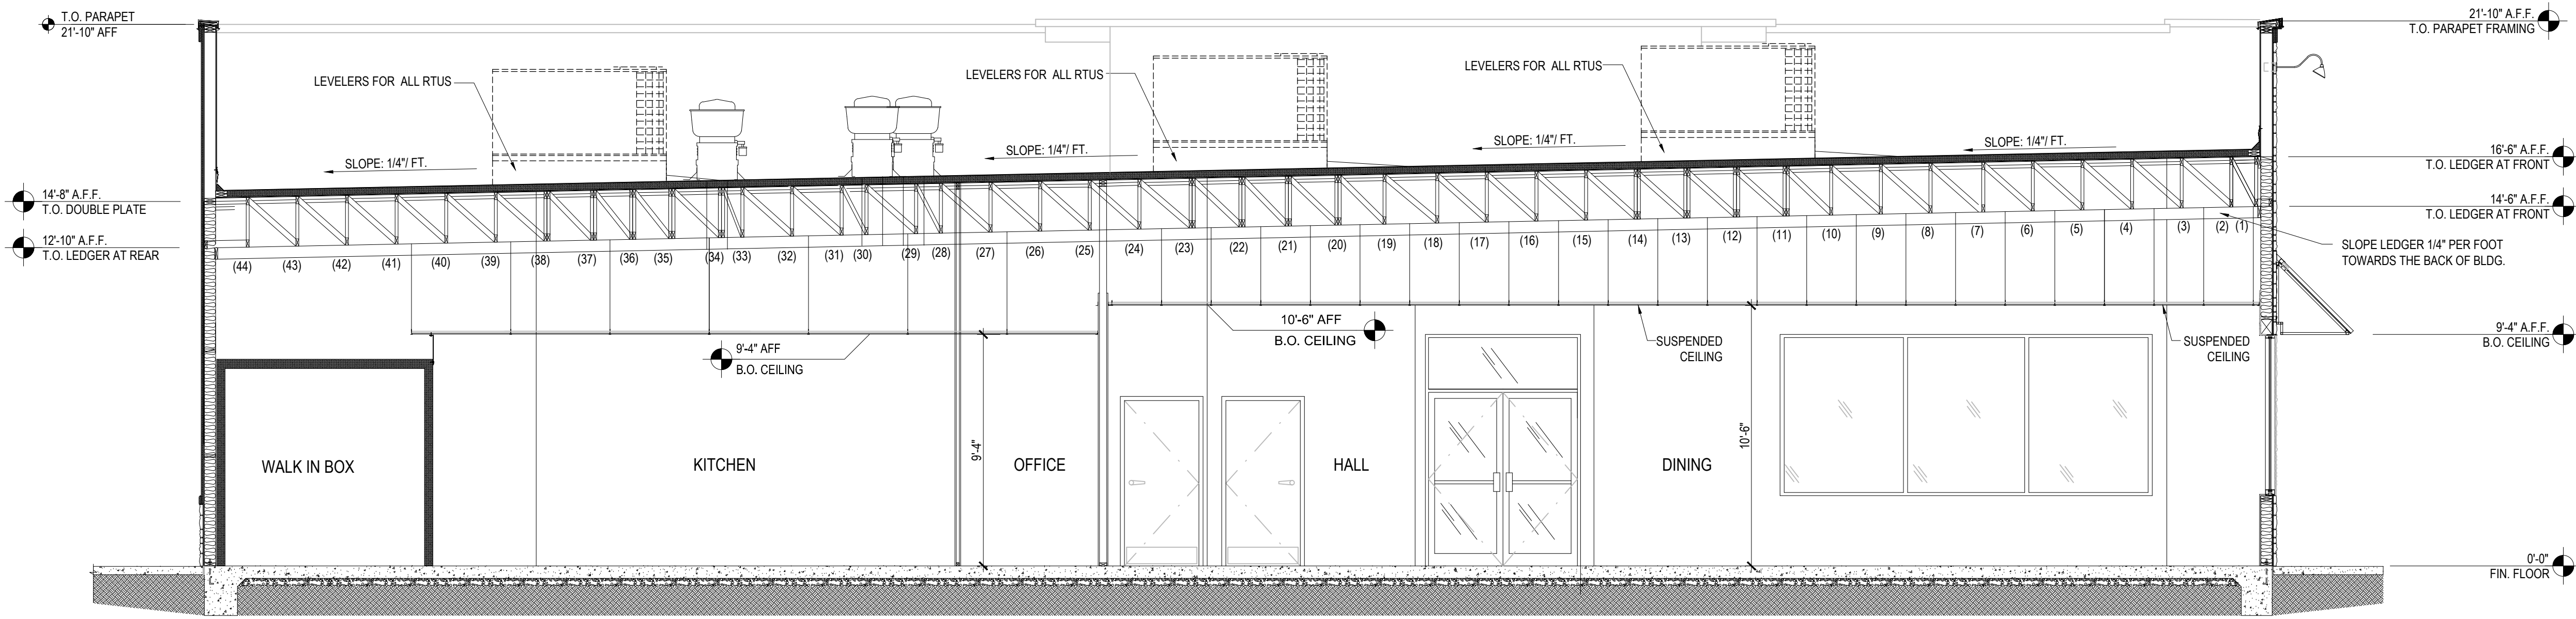
LEFT & RIGHT EXTERIOR ELEVATIONS

SHEET NUMBER:

A301


PROJECT NUMBER

POP15003



BUILDING SECTION

2

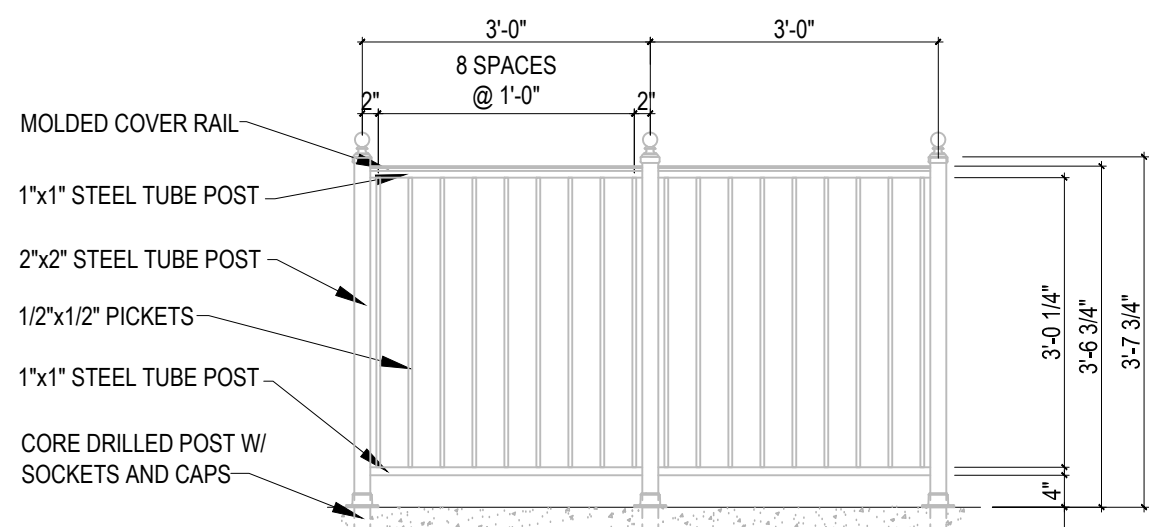

NOTE:
INCLUDE IN METAL PACKAGE
AND INSTALLED BY G.C.

GUARDRAIL DETAIL
1/2" - 1'-0"

18



NOTE:
CONTRACTOR TO FIELD
VERIFY DIMENSIONS.

DOOR ELEVATION

STOREFRONT DETAIL
1/2" - 1'-0"

17

DIVISION 7: THERMAL AND MOISTURE PROTECTION

SECTION 7A: BUILDING INSULATION

GENERAL PROVISIONS

- SCOPE: FURNISH AND INSTALL FIBERGLASS INSULATION AND ROOF INSULATION TO PROVIDE A COMPLETELY INSULATED THERMAL SHELL WITH NO BREAKS OR PENETRATIONS.
- NOTES: INSULATION VALUES SHALL COMPLY WITH STATE AND LOCAL CODE REQUIREMENTS AND/OR VALUES SHOWN ON THE DRAWINGS AND SPECIFIED HEREIN, WHICHEVER REQUIREMENT PROVIDES THE GREATER "R" VALUE.
- QUALITY CONTROL: THE OWNER SHALL BE NOTIFIED WHEN THE INSULATION IS IN PLACE, PRIOR TO THE INSTALLATION OF FINISH MATERIALS.

MATERIALS

- FIBERGLASS INSULATION CONCEALED IN WALLS BY OWENS-CORNING OR JOHNS-MANVILLE. 5 1/2", R-19, FIBERGLASS ROLL INSULATION WITH KRAFT TYPE VAPOR BARRIER ON INSIDE FACE.
- FIBER GLASS INSULATION EXPOSED ABOVE CEILING BY OWENS-CORNING OR JOHNS-MANVILLE. 5 1/2", R-19 FIBERGLASS ROLL INSULATION WITH INTEGRAL FOIL REINFORCED KRAFT FACING ON INSIDE FACE WITH FLAME HAZARD RATING OF 25/50 OR LESS.
- ROOF INSULATION BOARD: CLOSED CELL POLYISOCYANURATE FOAM CORE WITH FACTORY-LAMINATED FOIL FACES. FOAM CORES WITH FLAME SPREAD OF 25 OR LESS AND COMPRESSIVE STRENGTH OF 20 PSI OR GREATER (ASTM D-1621) WITH A MINIMUM AGED R VALUE OF 16 BY ONE (1) OF THE FOLLOWING APPROVED MANUFACTURERS:
 - AC FOAM SUPREME BY ATLAS INDUSTRIES
 - THERMA ROOF PLUS BY R-MAX
 - TEM-PRO SP BY THE TEMPLE EASTEX

THE LISTED INSULATIONS ARE AVAILABLE THROUGH QUALIFIED ROOFING INSTALLERS. SEE NATIONAL ACCOUNTS INDEX.

- PERIMETER FOUNDATION INSULATION (AND 2" MASONRY WALL CAVITY INSULATION WHEN SHOWN) SHALL BE STYROFOAM SM BY DOW CHEMICAL CO. OR APPROVED EQUAL, 2" THICK. THERMAL CONDUCTIVITY SHALL BE .20 BTU/HR/SQ.FT./INCH THICKNESS AT 75 DEG F MEAN TEMPERATURE, R-10 VALUE.
- CONCRETE BLOCK CELL INSULATION FOR MASONRY WALLS SHALL BE SILICONE-TREATED PERLITE LOOSE-FILL INSULATION BY A MEMBER OF THE PERLITE INSTITUTE.

PERFORMANCE

1. INSTALLATION:

- FIBERGLASS INSULATION: STAPLE AND/OR TAPE IN PLACE WITH VAPOR BARRIER SIDE INWARD. ALL JOINTS SHALL BE LAPPED TO PREVENT MOISTURE VAPOR MIGRATION. ALL PENETRATIONS AND PLUMBING AND ELECTRICAL BOXES SHALL BE INSULATED ON THE OUTWARD SIDE. ANY JOINTS NOT OVER WOOD FRAMING OR BLOCKING SHALL BE TAPED THOROUGHLY. STUFF AROUND DOOR FRAMES AND CLOSELY SPACED FRAMING MEMBERS.
- ROOF INSULATION: USE MECHANICAL FASTENERS WITH STEEL OR WOOD DECK. INSTALL IN ACCORDANCE WITH MANUFACTURER'S INSTRUCTIONS OF SIX (6) PER BOARD MINIMUM. STAGGER PANEL END JOINTS AT ADJACENT PANEL MID POINT.
- PERIMETER FOUNDATION INSULATION: INSTALL FROM TOP OF SLAB DOWNWARD 24" WHEN FOUNDATION DEPTH PERMITS. OTHERWISE INSULATION SHALL EXTEND FROM TOP TO BOTTOM OF SLAB AND THEN HORIZONTALLY UNDER SLAB 24" TOWARD INTERIOR OF BUILDING.
- MASONRY CAVITY WALL INSULATION: INSTALL IN CAVITY WHEN SHOWN BETWEEN MASONRY WALL REINFORCING AS WALL IS BEING LAID.
- CONCRETE BLOCK CELL INSULATION: INSTALL WHEN SHOWN IN ACCORDANCE WITH MANUFACTURER'S RECOMMENDATIONS.

SECTION 7B: MEMBRANE ROOFING

GENERAL PROVISIONS

- SCOPE: FURNISH AND INSTALL MEMBRANE ROOFING SYSTEM THROUGH THE NATIONAL ACCOUNT PROGRAM DESCRIBED BELOW, INCLUDING ALL FLASHING, BACK FLASHING INSULATION AND RELATED MATERIALS REQUIRED FOR A COMPLETE, WATERPROOF INSTALLATION.
- NOTES:
 - PAYMENT FOR THIS SECTION WILL BE MADE AFTER RECEIPT OF MANUFACTURER'S FULL REPLACEMENT NDL (NO DOLLAR LIMIT) 10-YEAR WARRANTY FOR MATERIALS AND LABOR.
 - CAUTION: THE HVAC SYSTEM IS DESIGNED WITH THE THERMAL CHARACTERISTICS OF HI-TUFF MEMBRANE AND NO VARIATIONS ARE ALLOWED UNLESS GIVEN PRIOR WRITTEN APPROVAL BY POPEYES ARCHITECTURE AND ENGINEERING DEPARTMENT.
- NATIONAL ACCOUNTS:
 - A NATIONAL ACCOUNT HAS BEEN ESTABLISHED WITH JPS ELASTOMERICS CORPORATION FOR PURCHASING HI-TUFF ROOFING SYSTEM MATERIALS. REFER TO TITLE SHEET FOR INFORMATION.
 - INSTALLATION OF ROOF MEMBRANE SYSTEM ONLY BY MANUFACTURER APPROVED INSTALLERS. USING NON-APPROVED INSTALLERS MAY VOID WARRANTY PROGRAM WITH MANUFACTURER.
 - NOTIFY ROOFING CONTRACTOR A MINIMUM OF THREE (3) WEEKS IN ADVANCE OF NEEDED ROOF INSTALLATION DATE.
 - MATERIALS AND INSTALLATION FOR ROOFING AND FLASHING SHALL ONLY BE THROUGH THE NATIONAL ACCOUNT PROGRAM DESCRIBED.
 - MANUFACTURER'S REPRESENTATIVE SHALL INSPECT THE ROOF INSTALLATION, IF REQUIRED, PRIOR TO ISSUING 10-YEAR NDL MATERIALS AND LABOR WARRANTY.

MATERIALS

SINGLE PLY-ROOF

- MEMBRANE ROOFING SYSTEM: HI-TUFF, MECHANICALLY FASTENED 45-MIL.
 - ROOF MEMBRANE: 45-MIL, REINFORCED, HI-TUFF, WHITE, HYPALON ROOF MEMBRANE.
 - MEMBRANE FLASHING: SAME AS ROOF MEMBRANE, EXCEPT WHERE "MOLDING" IS REQUIRED.
 - MOLDED FLASHING: 55-MIL, NON-REINFORCED, WHITE, HI-TUFF HYPALON FLASHING MEMBRANE.
 - METAL FLASHING AND ROOF SCUPPERS: HI-TUFF COATED METAL AS REQUIRED.
 - MEMBRANE FASTENERS: FOR WOOD/STEEL DECK, JPS ELASTOMERICS (OLYMPIC CR-10) FASTENERS WITH EXTRA FLUOROCARBON CORROSION-RESISTANT COATING. FASTENERS ARE NOT TO PROTRUDE BELOW ROOF DECK GREATER THAN 1".
 - INSULATION FASTENERS: FOR WOOD/STEEL DECK STANDARD JPS ELASTOMERICS (OLYMPIC CR-10) FASTENERS WITH CORROSION-RESISTANT COATING.
 - MEMBRANE ADHESIVE - JPS ELASTOMERIC BONDING ADHESIVE - SOLVENT-BASED CONTACT ADHESIVE.
 - PRIMER: SOLVENT-BASED SYNTHETIC RUBBER PRIMER USED TO PREPARE MEMBRANE FOR REPAIR.
 - CAULKING: JPS HI-TUFF ALL-PURPOSE SEALANT OF EXTERIOR GRADE.
 - TRAFFIC PAD: JPS WALKWAY PAD.
- ROOF INSULATION BOARD: CLOSED CELL POLYISOCYANURATE FOAM CORE WITH FACTORY-LAMINATED FOIL FACES. FOAM CORE WITH FLAME SPREAD OF 25 OR LESS AND COMPRESSIVE STRENGTH OF 20 PSI OR GREATER (ASTM D-1621) WITH A MINIMUM R VALUE OF 16. AC FOAM SUPREME BY ATLAS OR EQUAL APPROVED BY JPS ELASTOMERICS, INC.
- NAILERS: TREATED WOOD.

PERFORMANCE

- SURFACE PREPARATION: THE ENTIRE AREA TO BE ROOFED SHALL BE FREE OF DEBRIS AND GROSS IRREGULARITIES.
- ROOF FLASHING: FLASHINGS SHALL BE INSTALLED IN ACCORDANCE WITH JPS ELASTOMERICS' INSTRUCTIONS.
 - FLASHING MEMBRANE SHALL BE FULLY ADHERED, USING BONDING ADHESIVE, TO VERTICAL SUBSTRATES. IN ADDITION, MEMBRANE FLASHINGS SHALL BE MECHANICALLY FASTENED AT 6" O.C. HOT AIR WELDING SHALL BE USED AT THAT PORTION OF THE FLASHING THAT OVERLAPS 6" ONTO THE FIELD OF THE ROOF MEMBRANE OR ONTO AN ADJACENT FLASHING.
- ROOFING SHEET: MEMBRANE SHALL BE UNROLLED IN AN AREA TO BE COVERED. MECHANICAL FASTENERS AND PLATES SHALL BE INSTALLED ALONG THE LEADING EDGE OF THE MEMBRANE AND AT THE SEAM, THROUGH THE INSULATION AND INTO THE ROOF DECK. SPACING PATTERN AS DETERMINED BY JPS ELASTOMERICS TO RESIST LOCAL WIND LOADS. ADJOINING ROLLS OF THE MEMBRANE SHALL OVERLAP THE FASTENED EDGE OF THE INSTALLED MEMBRANE BY 4 1/2" MINIMUM. SEAM AREA SHALL BE CLEANED AND HOT AIR WELDED WITH AN APPROVED HOT AIR WELDING MACHINE. INSTALL EXTRA LAYER OF MEMBRANE UNDER EQUIPMENT AND EQUIPMENT SUPPORTS NOT ATTACHED THROUGH ROOF MEMBRANE.
- 4' X 8' INSULATION BOARDS ARE TO BE FASTENED TO THE DECK WITH A MINIMUM OF SIX (6) FASTENERS PER BOARD. ENSURE FASTENERS DO NOT PENETRATE CONDUIT OR OTHER ITEMS BENEATH THE ROOF DECK. STAGGER PANEL END JOINTS AT ADJACENT PANEL MID POINTS. USE MECHANICAL FASTENERS WITH STEEL OR WOOD DECK.
- TRAFFIC PAD: ADHERED TO ROOF WITH CONTACT ADHESIVE COMPATIBLE WITH ROOF MEMBRANE.
- CLEANUP: THE ROOFING CONTRACTOR SHALL CLEAN THE CONSTRUCTION AREA OF HIS DEBRIS AND SHALL REMOVE HIS DEBRIS TO A JOB SITE TRASH CONTAINER.
- WARRANTY: FURNISH TO THE OWNER THE MANUFACTURER'S NDL (NO DOLLAR LIMIT) 10-YEAR WARRANTY FOR FULL REPLACEMENT OF MATERIALS AND LABOR.

MODIFIED BITUMEN SHEET ROOFING

PART 1 - GENERAL

1.01 SUMMARY

- PROVIDE THE FOLLOWING:
 - WHITE GRANULAR MODIFIED BITUMEN ROOFING SYSTEM AND ROOFING SYSTEM AND ROOF INSULATION.

1.02 SUBMITTALS

- SUBMIT FOR APPROVAL SAMPLES, PRODUCT DATA, WARRANTY, TEST REPORTS, MAINTENANCE DATA.

1.03 QUALITY ASSURANCE

- COMPLY WITH GOVERNING CODES AND REGULATIONS. PROVIDE PRODUCTS OF ACCEPTABLE MANUFACTURERS WHICH HAVE BEEN IN SATISFACTORY USE IN SIMILAR SERVICE FOR THREE YEARS. USE EXPERIENCED INSTALLERS. DELIVER, HANDLE, STORE MATERIALS IN ACCORDANCE WITH MANUFACTURER'S INSTRUCTIONS.
- LISTING: UL CLASS [A] [B] [C] EXTERNAL FIRE EXPOSURE, AND CLASS [30] [60] [90] WIND-UPLIFT REQUIREMENTS.
- LISTING: FM CLASS I CONSTRUCTION.

1.04 WARRANTY

- ROOFING WARRANTY: MANUFACTURER'S 10 YEAR WARRANTY.

PART 2 - PRODUCTS

2.01 MATERIALS

- MANUFACTURERS: FIRESTONE BUILDING PRODUCTS CO., ELOTEX CORP., GAF BUILDING MATERIALS, SUPREME ROOFING AND WATERPROOFING OR APPROVED EQUAL. PROVIDE MATERIALS COMPATIBLE WITH ROOFING SPECIFICATIONS FOR SPECIFIC JOB FROM THE FOLLOWING:
 - TYPE: FULLY ADHERED
 - MODIFIER: ATACTIC POLYPROPYLENE (APP).
 - MODIFIER: STYRENE-BUTADIENE-STYRENE (SBS).
- MODIFIED BITUMEN SHEET ROOFING:
 - TYPE: FULLY ADHERED
 - MODIFIER: ATACTIC POLYPROPYLENE (APP).
 - MODIFIER: STYRENE-BUTADIENE-STYRENE (SBS).
- AUXILIARY MATERIALS:
 - VAPOR RETARDER: BITUMINOUS VAPOR RETARDER.
 - INSULATION: GLASS-FIBER BOARD.
 - INSULATION: PERLITE BOARD.
 - INSULATION: POLYISOCYANURATE-FOAM BOARD.
 - INSULATION: COMPOSITE INSULATION BOARD.
 - INSULATION: PHENOLIC-FOAM BOARD.
 - INSULATION: CELLULAR-GLASS BOARD.
 - INSULATION: FIBERBOARD.
 - INSULATION: EXTRUDED POLYSTYRENE BOARD.
 - WALKWAY PROTECTION BOARDS: COMPATIBLE WITH SYSTEM.
 - SHEET METAL ACCESSORIES: SMACNA AND NRCA RECOMMENDATIONS.

PART 3 - EXECUTION

3.01 INSTALLATION

- INSPECT SUBSTRATE AND REPORT UNSATISFACTORY CONDITIONS IN WRITING. BEGINNING WORK MEANS ACCEPTANCE OF SUBSTRATE. COORDINATE INSTALLATION WITH OTHER TRADES, INCLUDING CARPENTRY, FLASHING AND PENETRATING WORK.
- COMPLY WITH NRCA ROOFING AND WATERPROOFING MANUAL AND MANUFACTURER'S INSTALLATION INSTRUCTIONS.
- CLEAN, PRIME AND PREPARE SUBSTRATE.
- INSTALL INSULATION WITH TIGHTLY BUTTED JOINTS AND NEATLY FITTED AROUND PENETRATIONS.
- BEGIN ROOF INSTALLATION ONLY IN PRESENCE OF MANUFACTURER'S REPRESENTATIVE.
- INSTALL WALKWAY PROTECTION MEMBRANE AT LOCATIONS INDICATED AND WHERE REQUIRED TO PROVIDE ACCESS TO ROOF MOUNTED EQUIPMENT.
- RESTORE OR REPLACE DAMAGED COMPONENTS. PROTECT WORK FROM DAMAGE.

CORPORATE:

Z & H FOODS, INC.
3100 MAIN STREET #301
DALLAS, TEXAS 75226
ZHNFOODSINC.COM

CLIENT: **Z & H FOODS, INC.**
3100 MAIN STREET #301
DALLAS, TEXAS 75226



DATE DESCRIPTION

DATE DESCRIPTION

SHEET TITLE:

**BUILDING
SECTION**

SHEET NUMBER:

A400

PROJECT NUMBER:

POP15003

SPECIFICATIONS

1

Response to Staff Comments

To: *Wahid Alam
City of Mesa
Planning Division
55 N. Center St
Mesa, AZ 85201*

RE: *Popeyes Louisiana Kitchen – Restaurant with Drive-Thru – 1431 S Crismon Road,
Parcel No. 20081402A*

This Letter is to acknowledge and respond to comments detailed in your MEMORANDUM dated 12/10/2015 regarding the above mentioned project. Copies of your comments and this letter have been distributed to the project owner and the relevant consultants.

COMMENTS:

STAFF COMMENTS/ CONCERNS

1. SITEPLAN:
 - a. The site is within the shopping center of Home Depot as the anchor store.
 - i. **RESPONSE: Correct, IDStudio 4 is working in conjunction with Z and H Foods Inc. and Home Depot to develop one of out lot parcels in the shopping center**
 - b. The proposed building is a pad site in front of Home Depot in an existing parking lot.
 - i. **RESPONSE: see above**
 - c. The new pad site shall be required to provide 15' wide perimeter landscape yards along all four property lines.
 - i. **RESPONSE: During our pre application meeting there was no mention of a 15' setback requirement. We also received comments to provide the bailout lane.**
 - d. The proposed site plan eliminates the existing pedestrian connectivity from the Crismon Road Sidewalk to the Home Depot store front. Provide a modified path to maintain the pedestrian link.
 - i. **RESPONSE: Please see the site plan for this modification has already been addressed, see SD100 and reference keynote 10 for the location of the accessible pathway.**
 - e. Servicing trash enclosure at the location may conflict with customers entering the drive thru lane.
 1. **RESPONSE: Please see the revised site plan location of the trash enclosure. The angle has been adjusted as to not impede the drive-thru. Also depending on pick up times there may not be any cars present**

because of the operations of the Popeyes does not begin until 10:30 or 11:00am.

- f. Submit parking analysis for the entire shopping center with cross access from existing and proposed uses.

- i. **RESPONSE: See attachment**

- g. Show outdoor seating area (preferably covered) with furniture layout.

- i. **RESPONSE: The owners of the proposed Popeyes are not going to be implementing outdoor seating due to space constraints on the site.**

2. BUILDING DESIGN:

- Staff appreciates New Orleans design theme for the proposed building
 - i. **RESPONSE: We are glad you like it, as it relates to where the brand began.**
- We would recommend introducing appropriate architectural details that complements New Orleans architectural theme, for example:

- 1. Replace standing seam canopy with more appropriate design elements like balcony with iron work railing similar to proposed one over pickup window

- a. **RESPONSE: We eliminated the standing seam canopy and in its place are using flat awnings with cables, see revised elevations.**

- 2. Replace ElDorado stones with more appropriate one that belongs to the design theme, also remove stone wainscot.

- a. **RESPONSE: We replaced the stones with another stone, also from the manufacturer El Dorado, see physical sample. We removed wainscot, see elevations.**

- 3. Vary parapet height

- a. **RESPONSE: we adjusted the parapet to create a more dynamic façade, see elevation**

- 4. East elevation of the building faces Home Depot and drive thru customers, therefore it needs enhancement with more appropriate architectural details.

- a. **RESPONSE: We added architectural elements to the East elevation, stone to 8' and a shutter to match the rest of the building.**

- Provide color and material board

- i. **RESPONSE: See submittal**

- Submit hard copies of architectural color elevations (4 sides) in full size and 11x17

- i. **RESPONSE: See submittal**

3. LANDSCAPE DESIGN:

- Perimeter landscaping and interior parking lot landscaping requires plant materials per Section 11-33-3 and 11-33-4.

- i. **RESPONSE: See landscape response**

- Provide minimum 8' wide landscape islands per Section 11-33-4.

- i. **RESPONSE: See landscape response**

- Provide Foundation base per Section 11-33-5
 - i. **RESPONSE: See landscape response**
- Review the installation and maintenance requirements in Ch 11-33-2. Provide complete installation.
 - i. **RESPONSE: See landscape response.**

Shopping Center Parking Analysis:

Home Depot

105,700 sf

General office/retail 1 space to 375 sf

$105,700/375 = 282$ required spaces

401 spaces existing on the Home Depot's parcel 220-81-402B

Fletchers Auto Shop

Approx 5,840 sf

General Auto Repair, 1 space to 375 sf

$5,840/375 = 16$ required spaces

18 spaces existing on the Fletchers parcel 220-81-404

Jack in the Box

Approx 2,800 sf

Eating establishment with drive thru, 1 space to 100 sf

$2,800/100 = 28$ required spaces

29 spaces exist on the Jack in the Box parcel 220-81-403

Proposed Popeyes

2,840 sf

Eating establishment with drive thru, 1 space to 100 sf

$2,840/100 = 29$ required space

Providing 30 spaces total



Project Name: Popeye's Louisiana Kitchen
Project Address: 1431 S. Crismon Rd.
1st Review Date: December 10, 2015

First Landscape review comments

1. Perimeter landscaping and interior parking lot landscaping requires plant materials per Section 11-33-3 and 11-33-4.
Response: Landscape has been revised to meet requirements.
2. Provide minimum 8' wide landscape islands per Section 11-33-4.
Response: Landscape islands have been revised.
3. Provide foundation base per Section 11-33-5.
Response: Landscaping provided at foundation base.
4. Provide complete installation and irrigation information in your Construction Documents to Ensure survival of the landscaping
Response: Installation details and Irrigation Plans will be included in Construction Documents.

CITY OF MESA
Real Estate Services
P. O. Box 1466
Mesa, AZ 85211-1466

APN:
¼, Sec. T N, R E

CONSENT TO CONDITIONS & WAIVER OF LAND USE LAW CLAIMS

("Consent & Waiver")

The undersigned is the owner(s) ("Owner") of the parcel of land described in Exhibit 1 hereto (the "Property"). Owner has applied for and seeks the City's approval for a [Site Plan Modification. This request will allow for the development of a drive-thru facility] in case No. # (the "Land Use Application").

Owner agrees and consents to all the conditions and stipulations approved as part of or in connection with the Land Use Application. Owner waives any claim under Arizona Revised Statutes § 12-1134, including any right to compensation for reduction to the fair market value of the Property, that may now or in the future exist as a result of, or that arises out of, the approval or application of the Land Use Application or any stipulations and/or conditions of approval to the Land Use Application.

Owner represents and warrants to being the owner of fee title to the Property or to being a person who has legal authority to bind all fee title owners of the Property to this Consent & Waiver. The terms of this Consent & Waiver shall run with the land and shall be binding upon all subsequent landowners. Owner consents to the recordation of this Consent & Waiver.

If Owner withdraws the application for the Land Use Application prior to final action by the City, Owner is released from this Consent and Waiver.

Dated this 4th day of January, 20 16.

OWNER:

OWNER:

Jeffrey L. Bennett

Print Name



Sign Name


Print Name

Sign Name

City of Mesa – Planning Division, P. O. Box 1466, Mesa, AZ 85211-1466, 480-644-2385

STATE OF ~~ARIZONA~~ ^{TEXAS})
County of ~~Maricopa~~ ^{Ft. Bend}) ss.

On this 4th day of January, 2016, before me, the undersigned Notary Public, personally appeared Jeffrey Bennett, who acknowledged that this document was executed for the purposes therein contained.

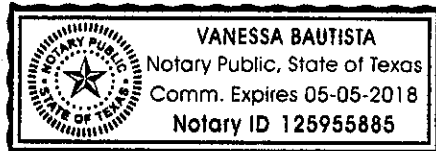

Vanessa Bautista
Notary Public

My Commission Expires: May 05, 2018

STATE OF ARIZONA)
County of Maricopa) ss.

On this ____ day of _____, 20____, before me, the undersigned Notary Public, personally appeared _____, who acknowledged that this document was executed for the purposes therein contained.

Notary Public

My Commission Expires: